


**BULK REQUIREMENTS
RB- ZONE
BULK REQUIREMENTS**

	MINIMUM	MAXIMUM
LOT AREA, NET (S.F.)	10,000	
LOT AREA, GROSS (S.F.)	12,000	
FRONTAGE (FT.)	60*	
FRONT YARD (FT.)	40**	
REAR YARD (FT.)	40	
SIDE YARD (FT.)	15	
BUILDING COVERAGE (%)		50
BUILDING HEIGHT (STORIES)		2

*MINIMUM FRONTAGE ON CURVED LOTS SHALL BE MEASURED AT THE FRONT SETBACK LINE
**MINIMUM FRONT YARD SHALL BE 40 FEET AS MEASURED FROM THE EDGE OF PAVEMENT.

GENERAL NOTES:
 1. VILLAGE OF SOUTH BLOOMING GROVE TAX MAP DESIGNATION: SEC. 220, BLK. 1, LOTS 3, 24, & 28
 2. TOTAL AREA OF PARCELS PER TAX MAPS: 6.66 AC.
 3. TOTAL PROPOSED NUMBER OF SINGLE FAMILY LOTS: 17
 4. PARCELS ARE LOCATED IN THE RR ZONING DISTRICT.
 5. BOUNDARY AND TOPOGRAPHY INFORMATION SHOWN TAKEN FROM A MAP ENTITLED "BOUNDARY & TOPOGRAPHIC SURVEY OF THE LANDS OF TIMOTHY LLC" AUTOMATED CONSTRUCTION ENHANCED SOLUTIONS, INC. PROFESSIONAL LAND SURVEYING 1229 ROUTE 300 SUITE 4, NEWBURGH, NY 12550. AS PREPARED BY JONATHAN N. MILLEN, L.L.S. DATED 11-26-2022

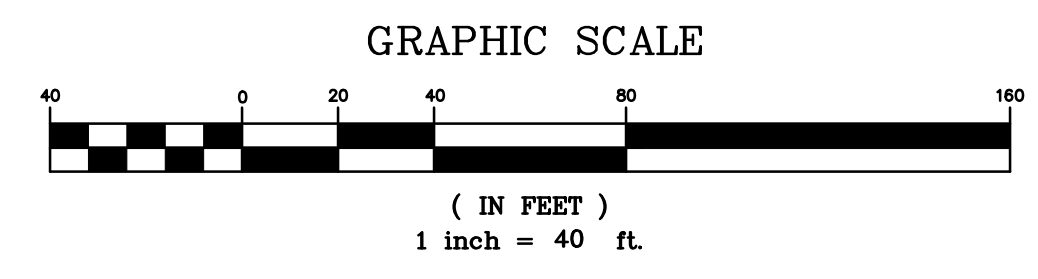

LEGEND

EXISTING PROPERTY LINE	—————
PROPOSED PROPERTY LINE	—————
EXISTING 2' CONTOUR LINE	—————
EXISTING 10' CONTOUR LINE	—————
BUILDING SETBACK LINE	—————
EXISTING EDGE OF PAVEMENT	—————
PROPOSED WALK	—————
PROPOSED CONC. CURB	—————
PROPOSED EASEMENT	—————

RECORD APPLICANT
 POSITIVE DEVELOPERS
 C/O ARON RAUCH
 580 RTE 208
 MONROE, NY

RECORD OWNERS
 7 TIMOTHY LLC.
 505 FLUSHING
 AVE STE 1D
 BROOKLYN NY 11205
 SDYV LLC
 2 SKILLMAN ST
 UNIT 413
 BROOKLYN NY 11205

DATE	REVISIONS
03-06-23	INITIAL PREPARATION

TREZA SUBDIVISION
 VILLAGE OF SOUTH BLOOMING GROVE, ORANGE COUNTY, NEW YORK
 PROJECT TITLE


SUBDIVISION PLAN
 DRAWING TITLE

KIRK ROTHER, P.E.
 CONSULTING ENGINEER, PLLC
 5 Saint Stephens Lane, Warwick, NY 10990
 (845) 988-0620

KIRK ROTHER, P.E. N.Y.S. LIC. NO. 079083


D.O.T. SHEET #	D.E.C. SHEET #	O.C.H.D. SHEET #	SHEET #
N.A.	N.A.	N.A.	1 OF 4

CAD # 23103 PROJECT # 23103.0 SCALE AS SHOWN

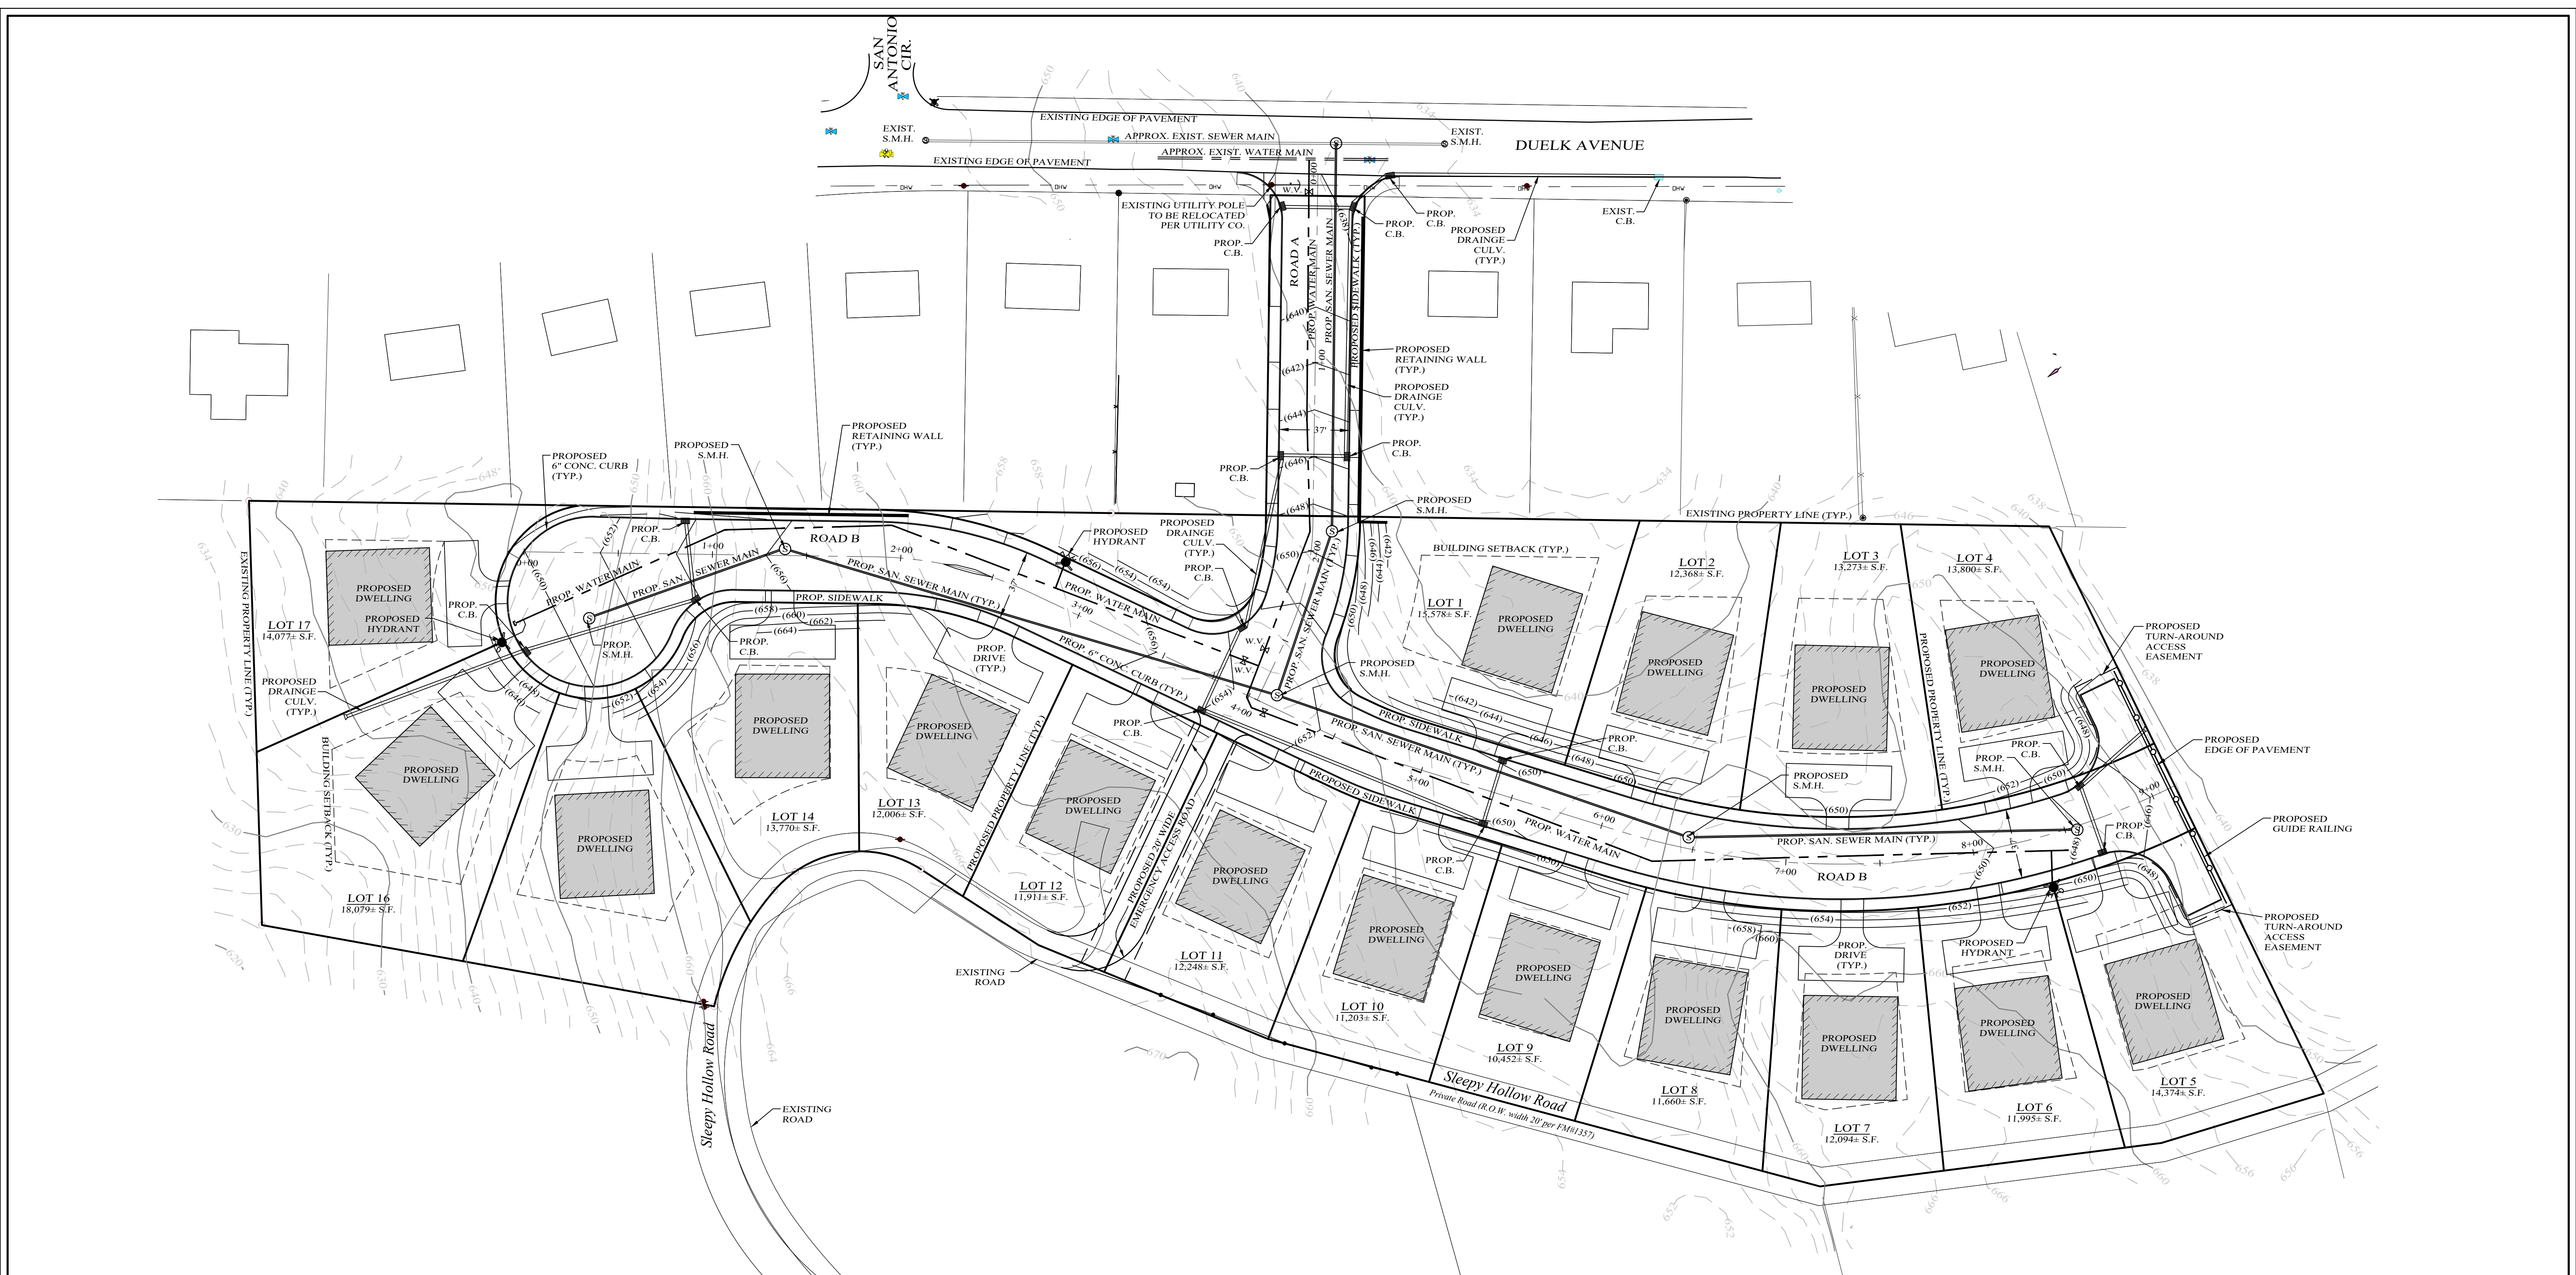

LEGEND

EXISTING PROPERTY LINE	---
EXISTING 2' CONTOUR LINE	-----
EXISTING 10' CONTOUR LINE	-----
BUILDING SETBACK LINE	-----
EXISTING EDGE OF PAVEMENT	-----
PROPOSED WALK	-----
PROPOSED CONC. CURB	-----
PROPOSED EASEMENT	-----

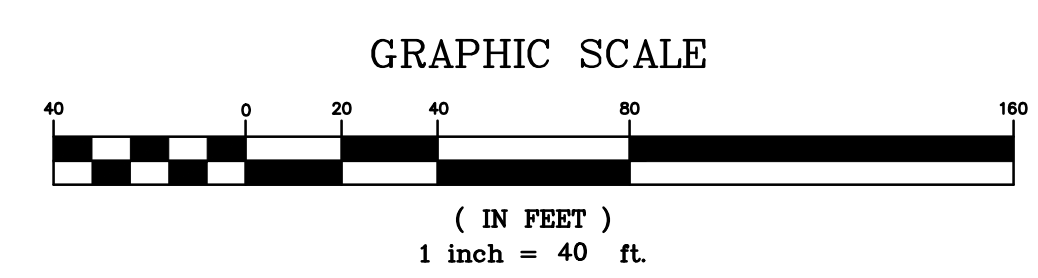

TREZA SUBDIVISION
 VILLAGE OF SOUTH BLOOMING GROVE, ORANGE COUNTY, NEW YORK
 PROJECT TITLE


GRADING & UTILITY PLAN
 DRAWING TITLE

KIRK ROTHER, P.E.
 CONSULTING ENGINEER, PLLC
 5 Saint Stephens Lane, Warwick, NY 10990
 (845) 988-0620

DATE	03-06-23	INITIAL PREPARATION	DATE	
DATE		REVISIONS	DATE	


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N.A.	N.A.	N.A.	2 OF 4
CAD #	PROJECT #	SCALE	
SKETCH	23103.0	AS SHOWN	

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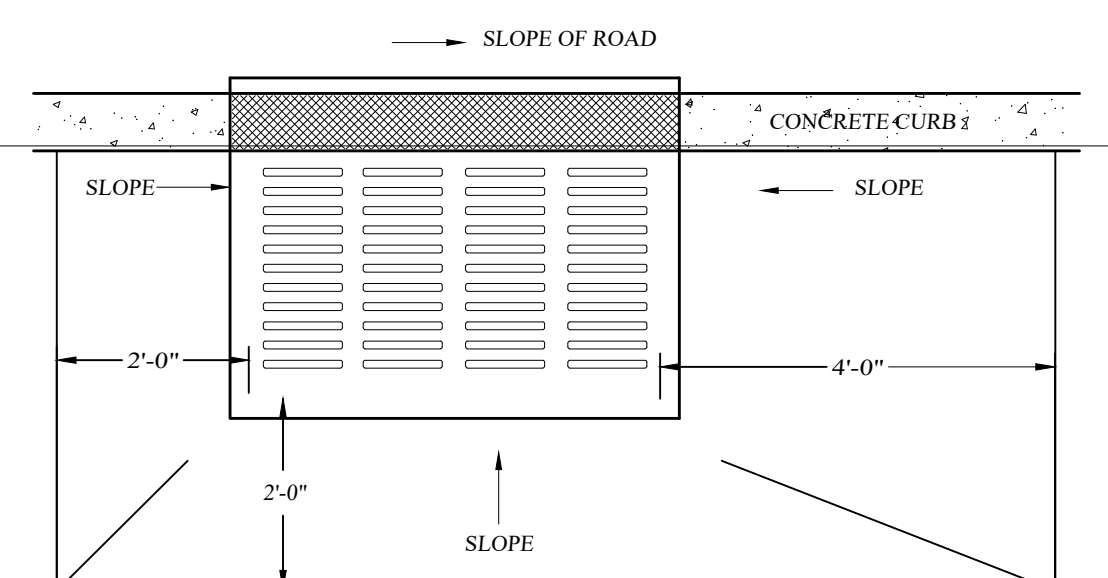
ROAD B PROFILE

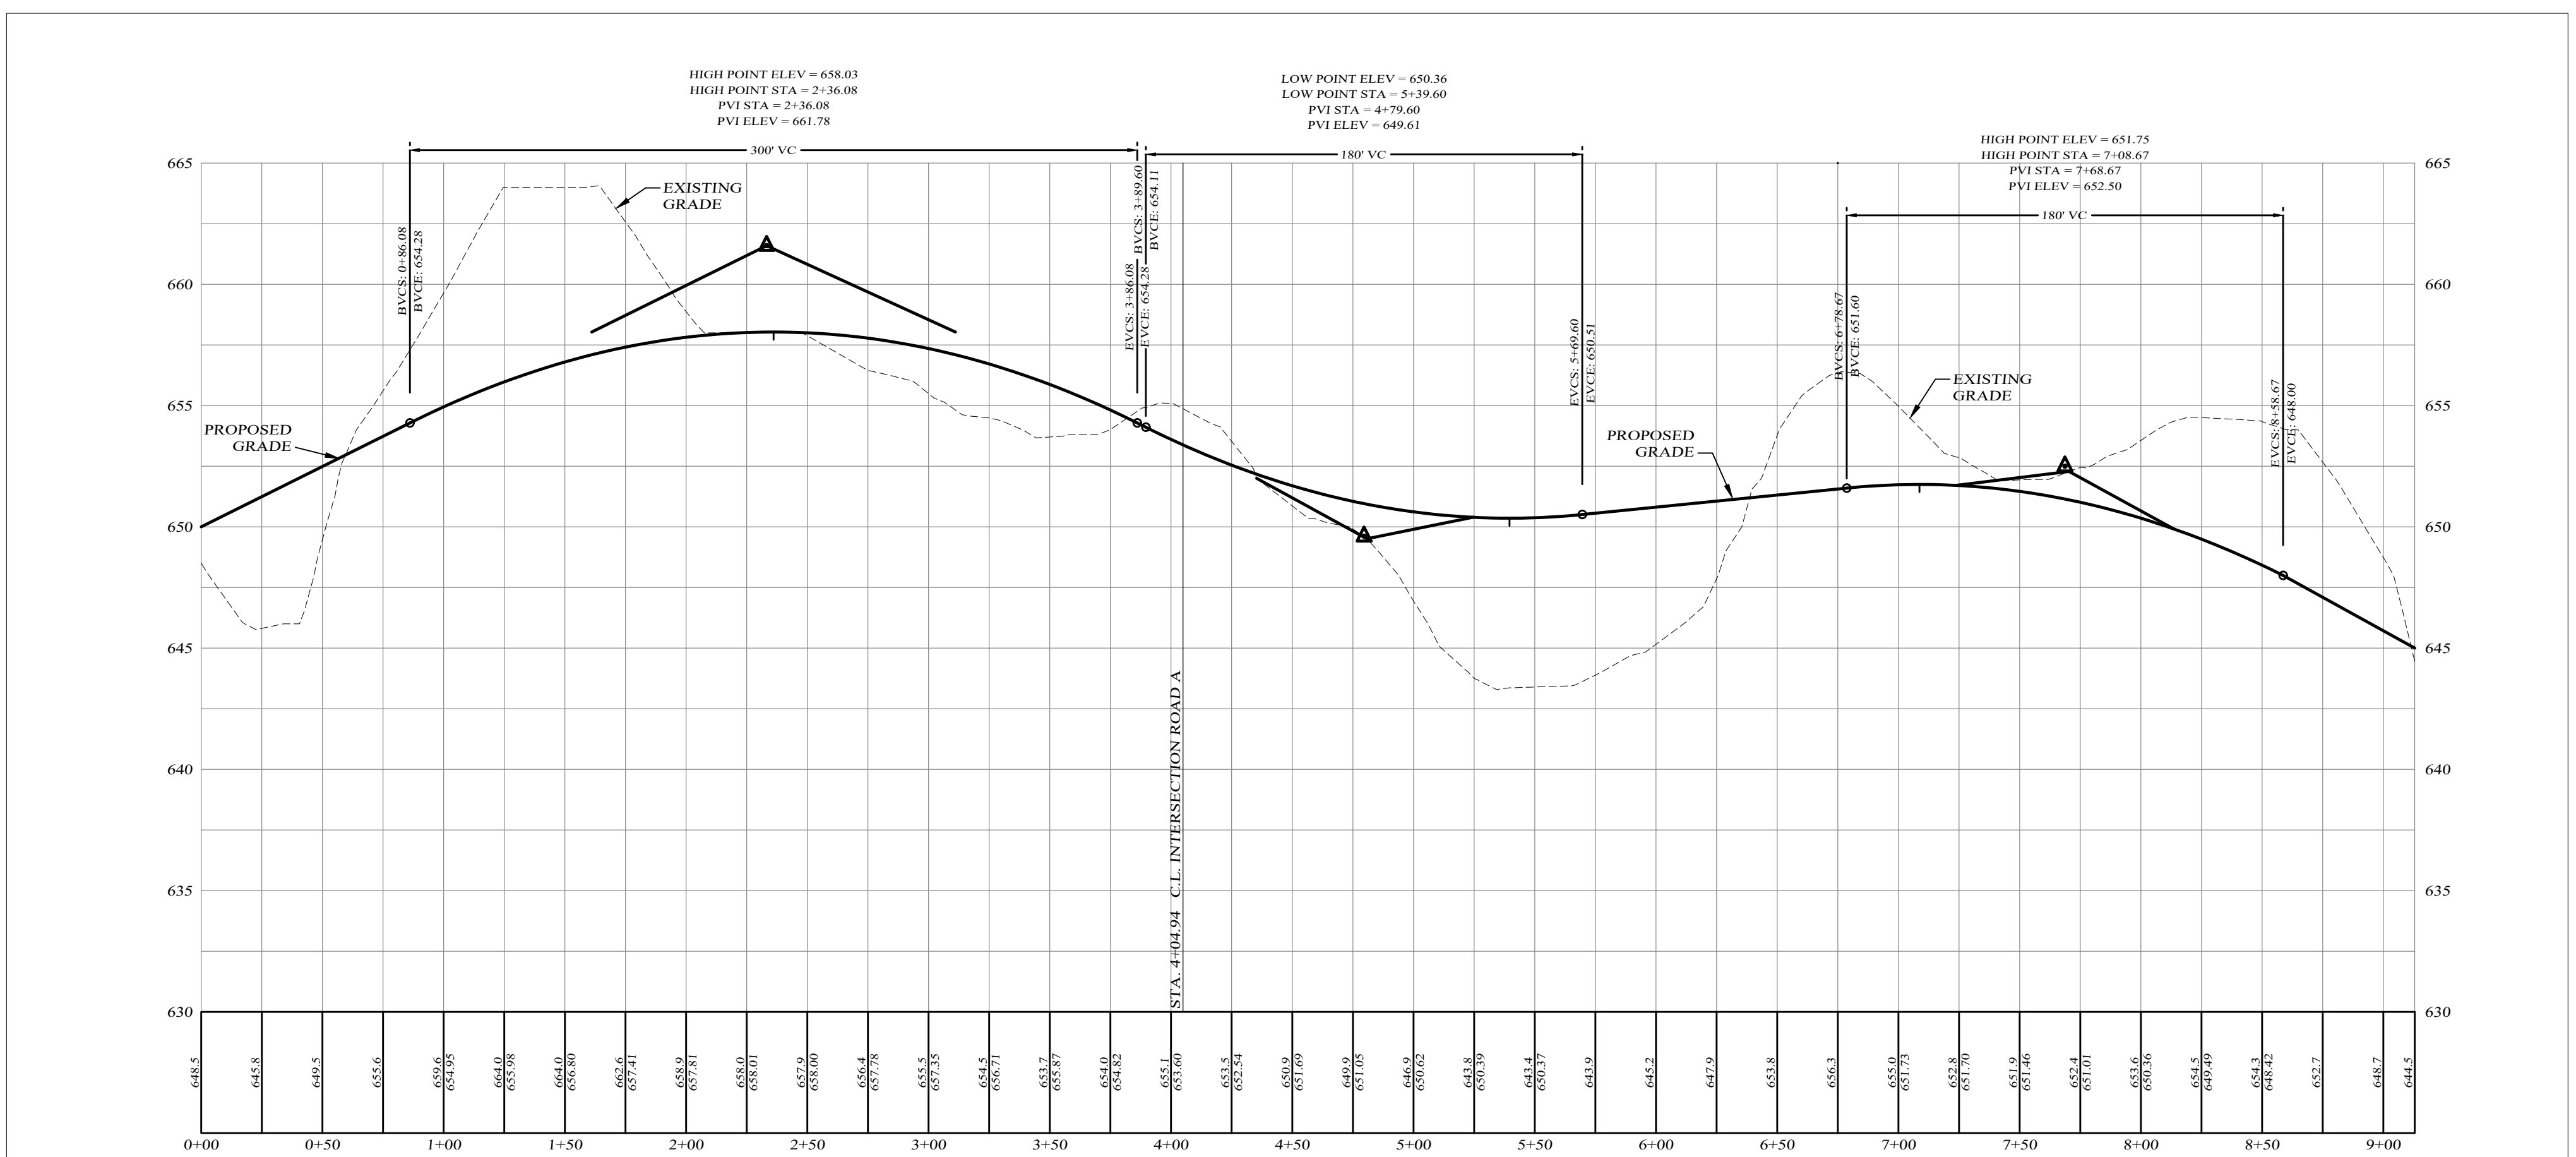SCALES:
HOR: 1" = 50'
VER: 1" = 5'




ROAD A PROFILE

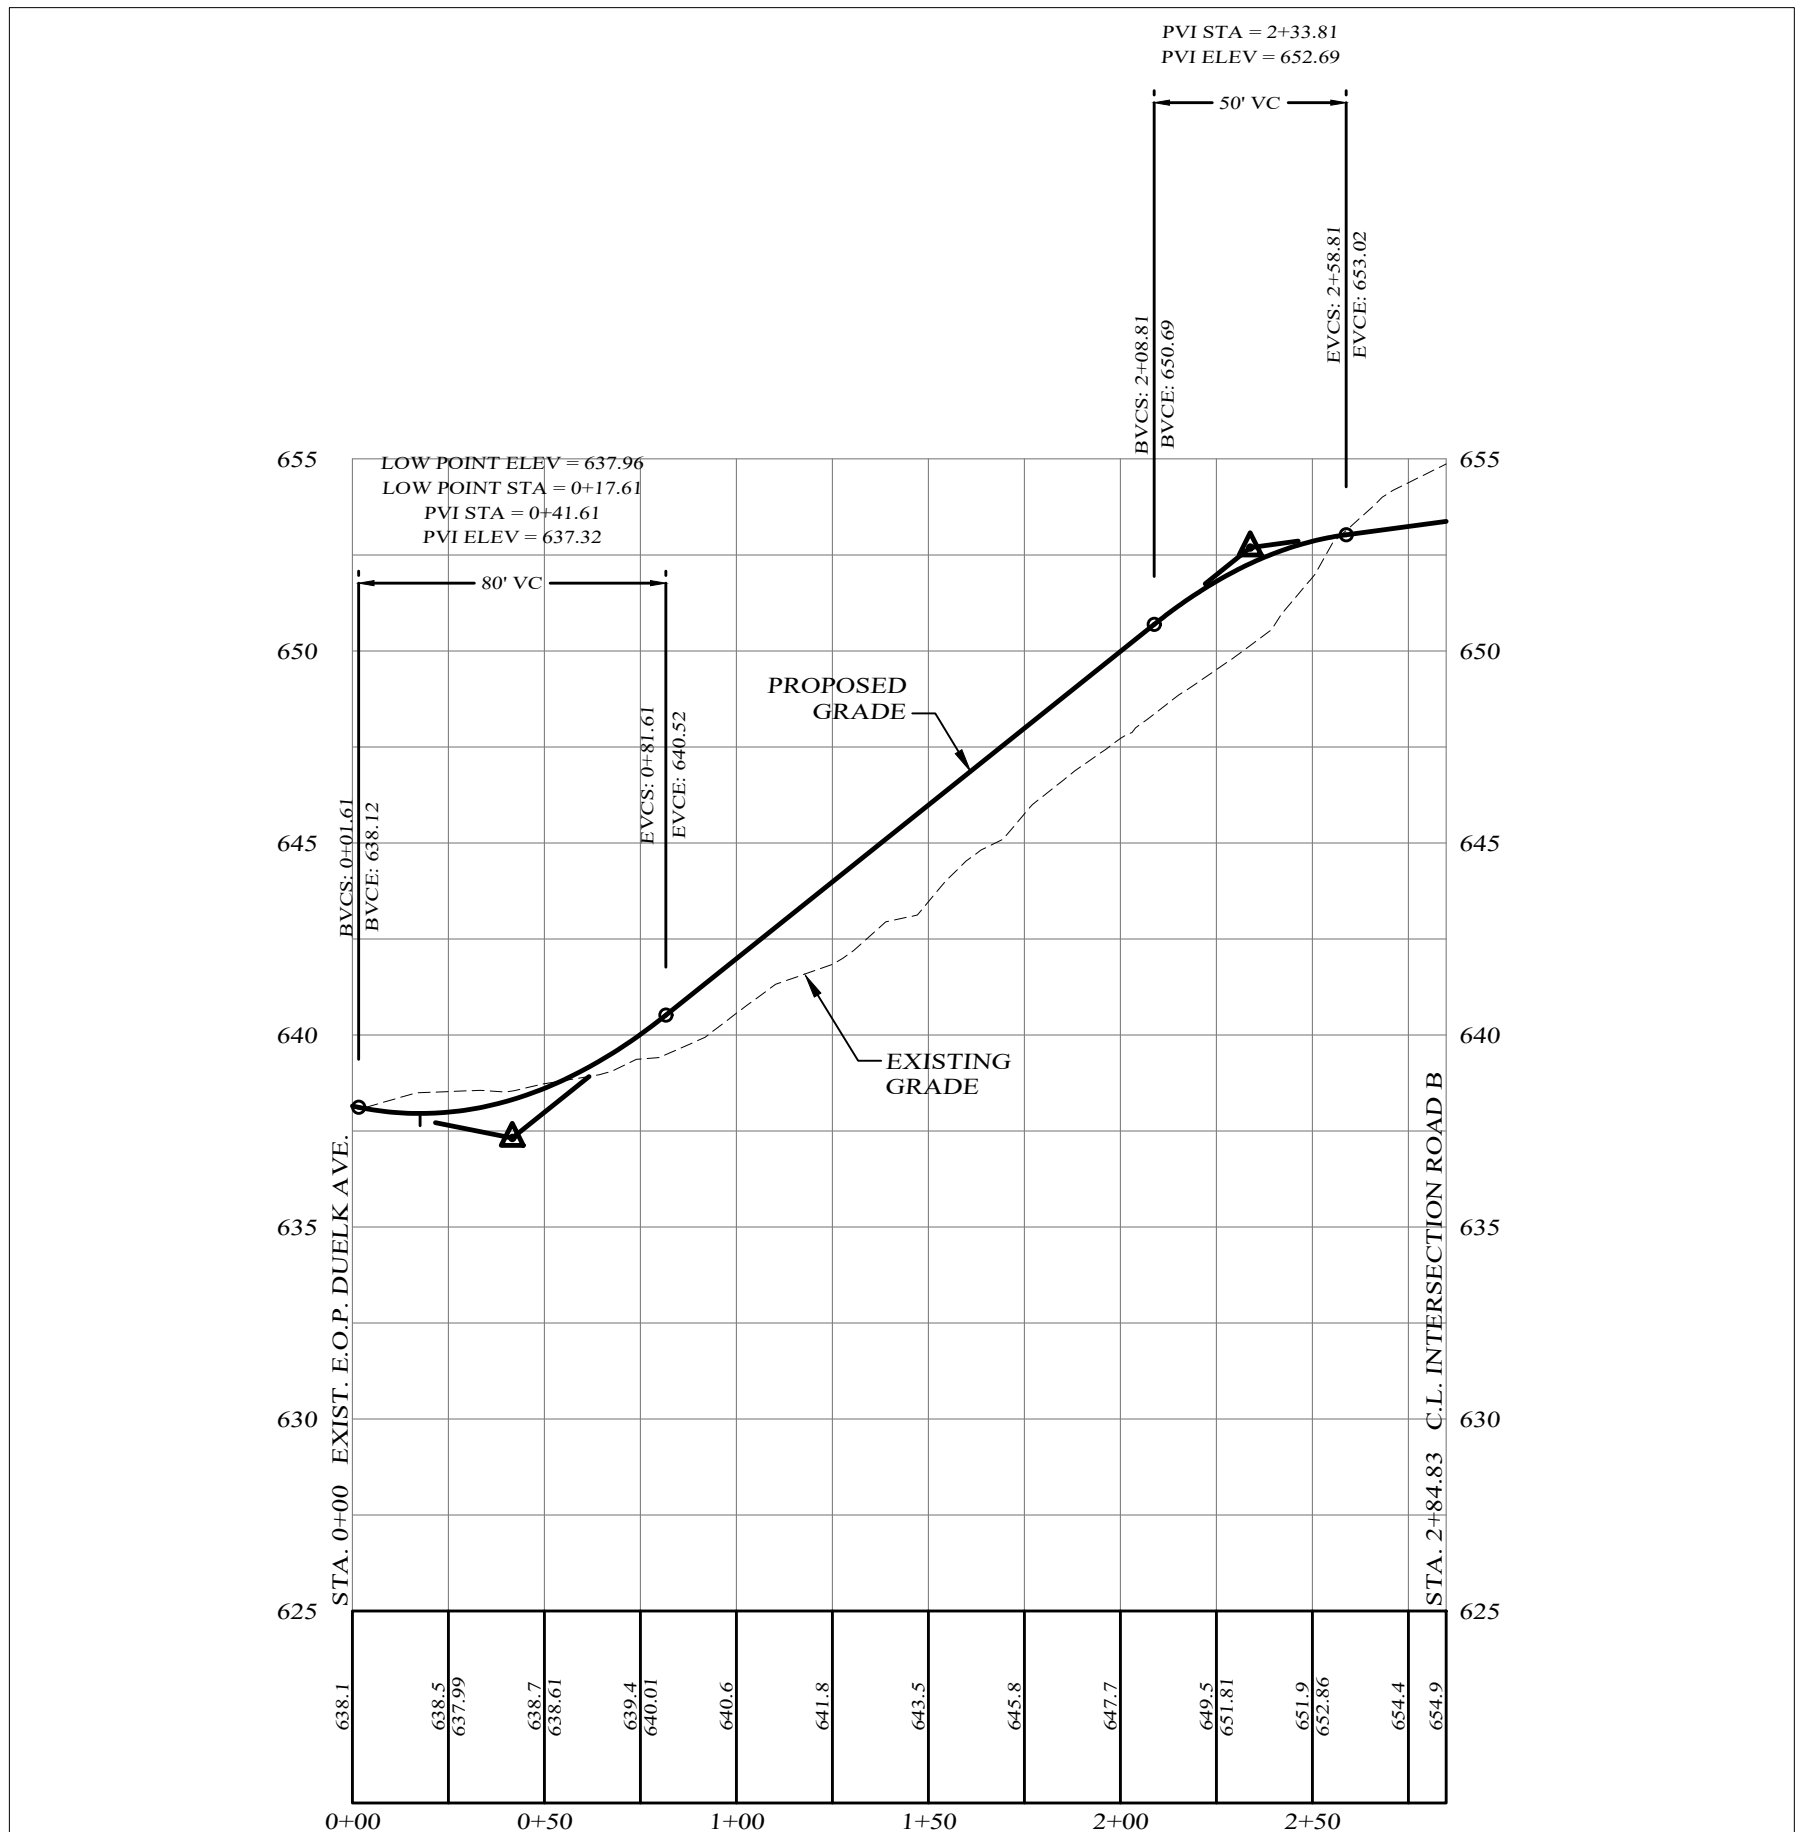
SCALES:
HOR: 1" = 50'
VER: 1" = 5'




PLAN

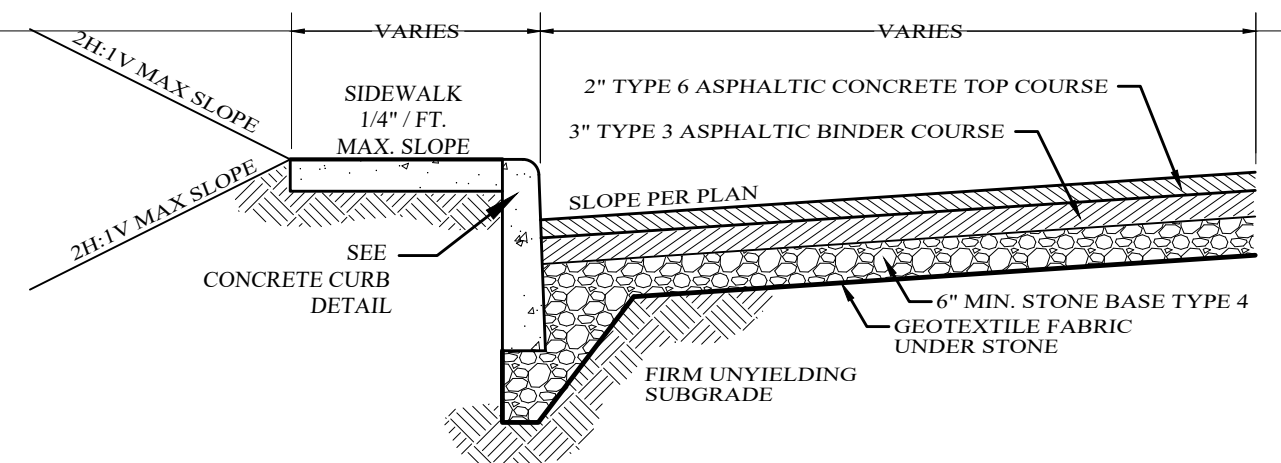


**TYPICAL PAVEMENT SECTION
PARKING LOTS & DRIVEWAYS**
NOT TO SCALE

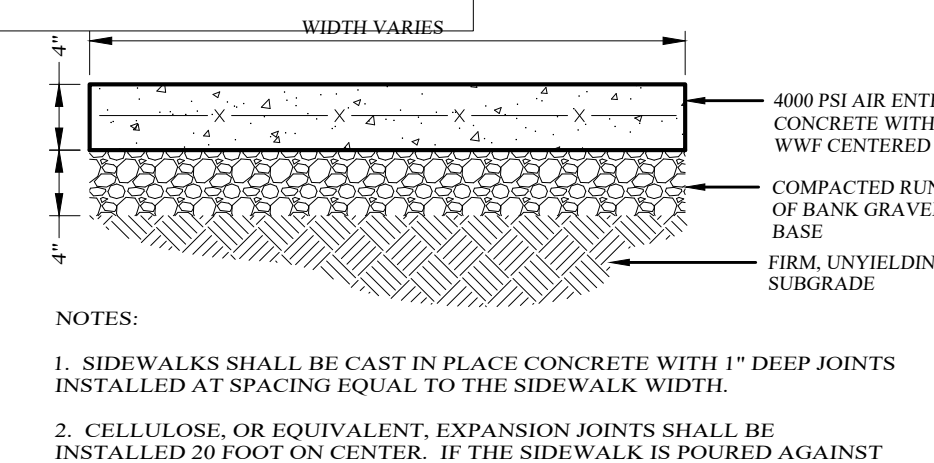

CONCRETE SIDEWALK DETAIL
NOT TO SCALE

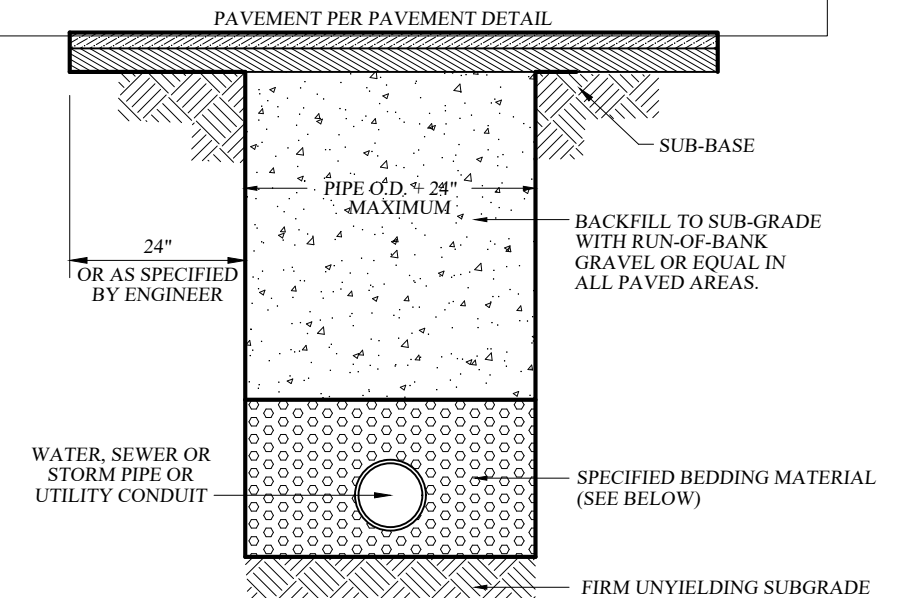


PIPE BEDDING AND BACKFILL DETAIL
NOT TO SCALE

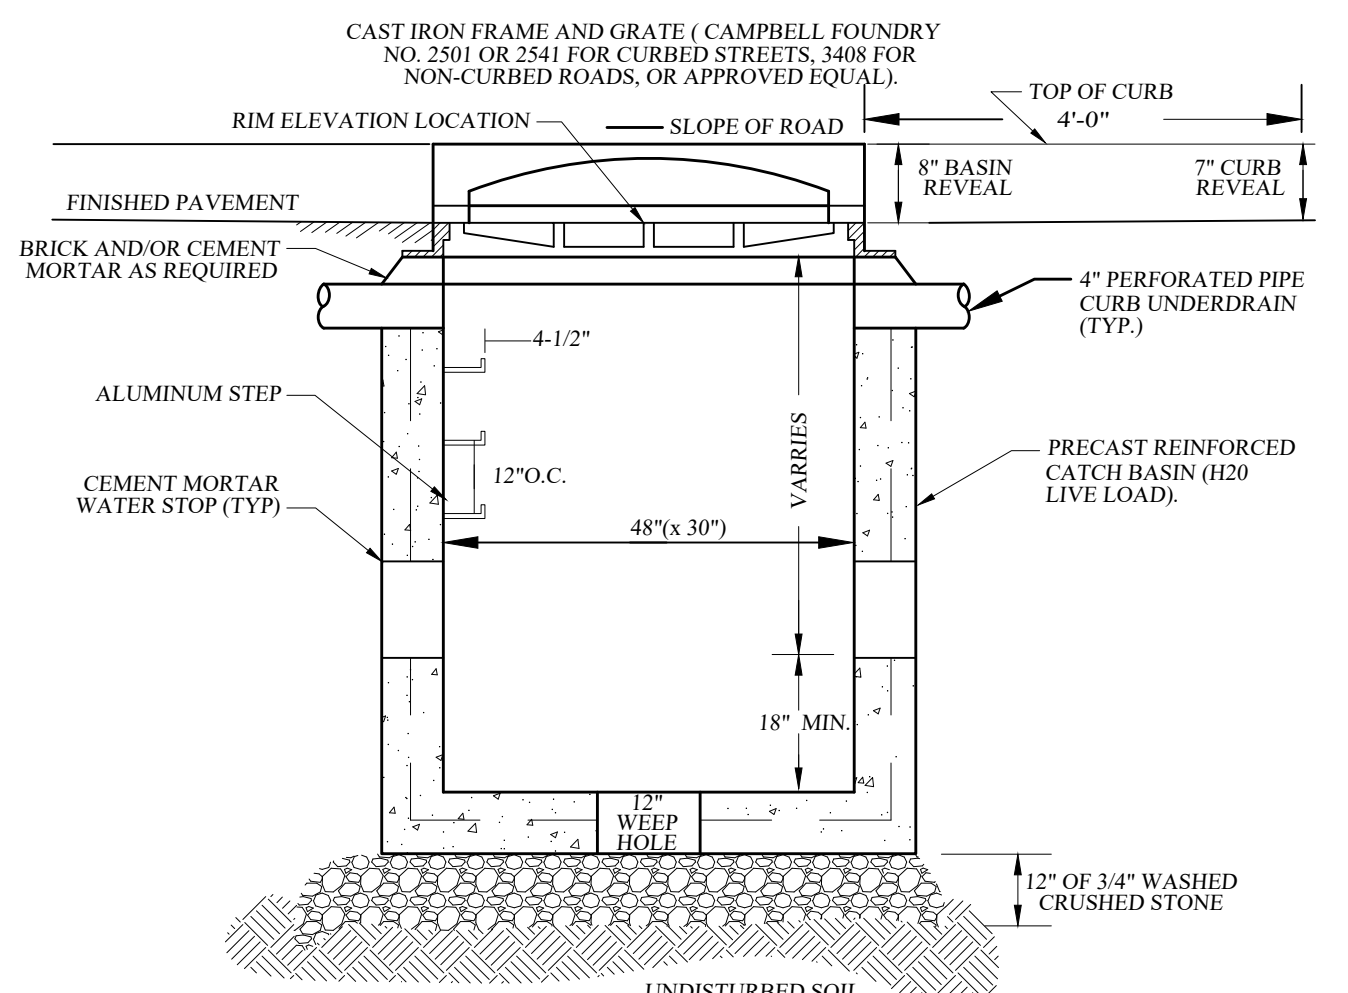

FRONT ELEVATION


NOTES:
1. BACKFILL AROUND CATCH BASIN TO BE COMPACTED IN MAX. 8" LIFTS.
2. THE ENDS OF ALL PIPES SHALL BE CUT OFF FLUSH WITH THE INSIDE SURFACE OF CATCH BASIN AND ADEQUATELY MORTARED.
3. PRECAST CONCRETE TO BE 4000 PSI @ 28 DAYS

PRECAST CONCRETE CURB INLET DETAIL
NOT TO SCALE

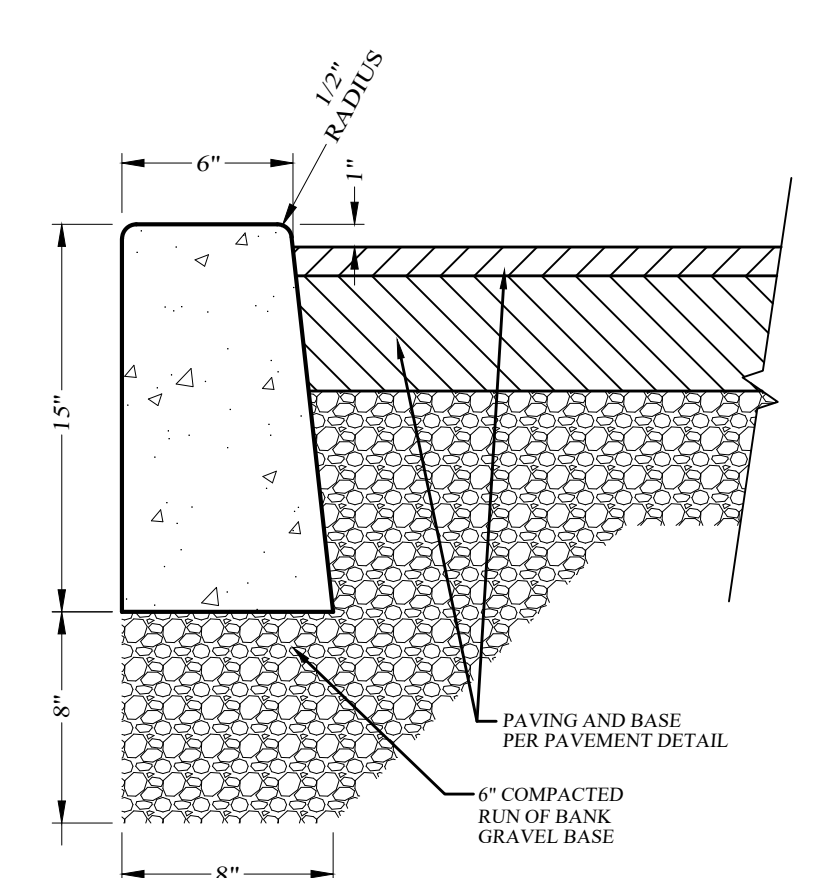


NOTES:
1. CURB SHALL BE CAST IN PLACE CONCRETE WITH CELLULOSE, OR EQUIVALENT, EXPANSION JOINTS INSTALLED AT TEN (10) FOOT INTERVALS.
2. MIX DESIGN SHALL BE IN ACCORDANCE WITH AMERICAN CONCRETE INSTITUTE GUIDELINES FOR CONCRETE EXPOSED TO FREEZING, THAWING AND DE-ICING CHEMICALS. CONCRETE SHALL HAVE A WATER-CEMENTITIOUS RATIO OF 0.45 AND AIR ENTRAINMENT OF 4 1/2% FOR A 1" NOMINAL AGGREGATE SIZE. CONCRETE TO TEST 4000 PSI AT 28 DAYS.

CONCRETE DROP CURB DETAIL
NOT TO SCALE

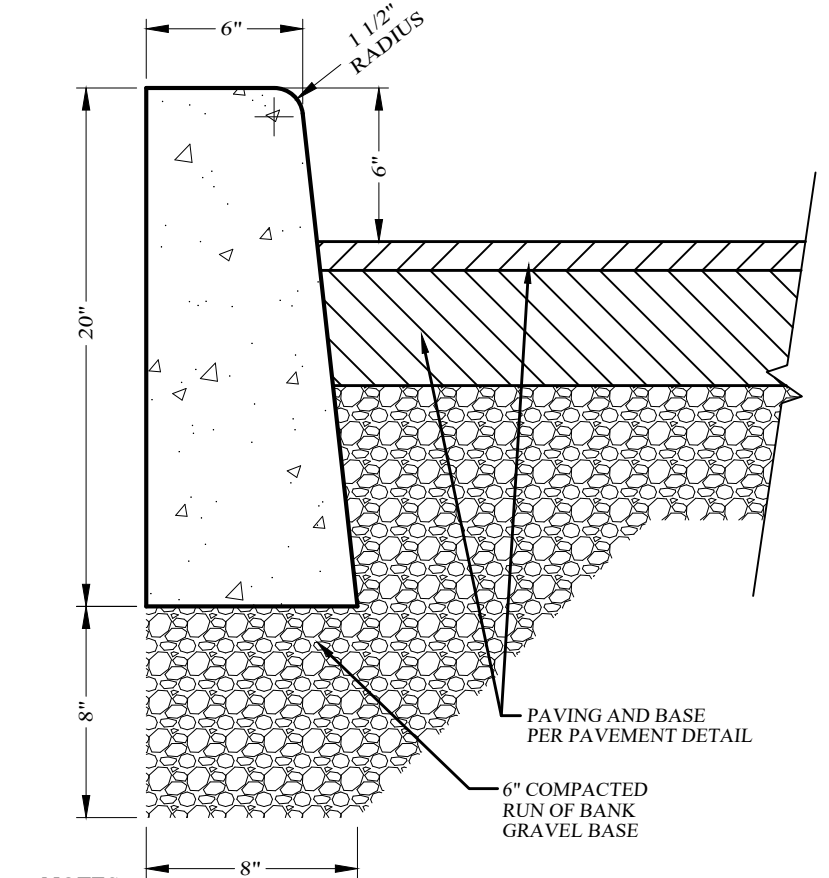

NOTES:
1. CURB SHALL BE CAST IN PLACE CONCRETE WITH CELLULOSE, OR EQUIVALENT, EXPANSION JOINTS INSTALLED AT TEN (10) FOOT INTERVALS.
2. MIX DESIGN SHALL BE IN ACCORDANCE WITH AMERICAN CONCRETE INSTITUTE GUIDELINES FOR CONCRETE EXPOSED TO FREEZING, THAWING AND DE-ICING CHEMICALS. CONCRETE SHALL HAVE A WATER-CEMENTITIOUS RATIO OF 0.45 AND AIR ENTRAINMENT OF 4 1/2% FOR A 1" NOMINAL AGGREGATE SIZE. CONCRETE TO TEST 4000 PSI AT 28 DAYS.

**CONCRETE CURB DETAIL
(WITHIN SITE)**
NOT TO SCALE

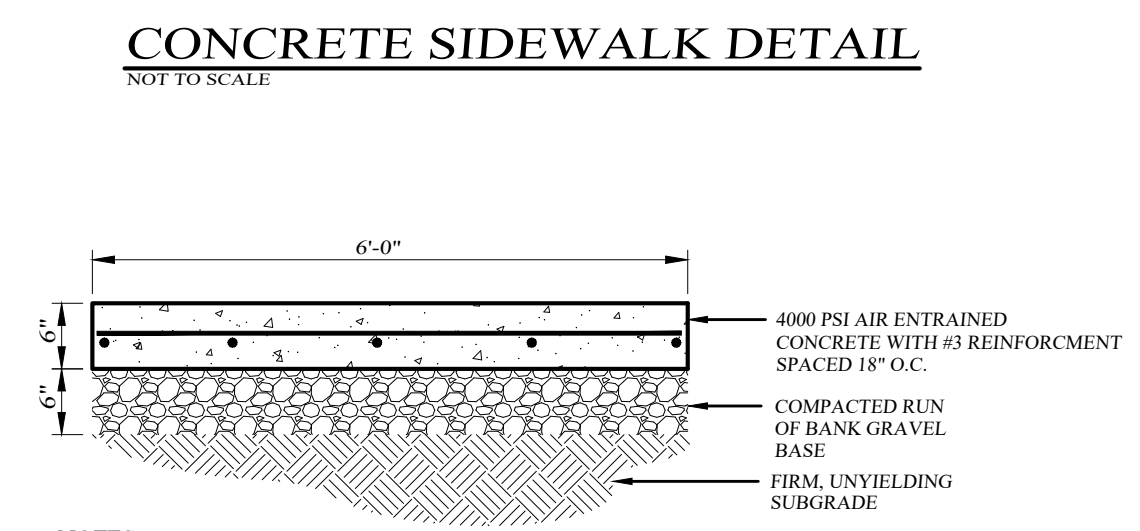

NOTES:
1. SIDEWALKS SHALL BE CAST IN PLACE CONCRETE WITH 1" DEEP JOINTS INSTALLED AT SPACING EQUAL TO THE SIDEWALK WIDTH.
2. CELLULOSE, OR EQUIVALENT, EXPANSION JOINTS SHALL BE INSTALLED 20 FOOT ON CENTER. IF THE SIDEWALK IS POURED AGAINST CONCRETE CURBS, BUILDINGS OR OTHER STRUCTURES, AN EXPANSION JOINT SHALL BE INSTALLED ALONG THE ENTIRE LENGTH OF CONTACT. SIDEWALKS SHALL SLOPE AWAY FROM BUILDINGS TO PROVIDE POSITIVE DRAINAGE AND CONFORM TO THE LATEST REVISION OF ALL APPLICABLE REGULATORY STANDARDS INCLUDING THE AMERICANS WITH DISABILITIES ACT.
3. MIX DESIGN SHALL BE IN ACCORDANCE WITH AMERICAN CONCRETE INSTITUTE GUIDELINES FOR CONCRETE EXPOSED TO FREEZING, THAWING AND DE-ICING CHEMICALS. CONCRETE SHALL HAVE A WATER-CEMENTITIOUS RATIO OF 0.45 AND AIR ENTRAINMENT OF 4 1/2% FOR A 1" NOMINAL AGGREGATE SIZE. CONCRETE TO TEST 4000 PSI AT 28 DAYS.
4. SIDEWALK SURFACE TO BE A BROOM FINISH WITH GROOVES RUNNING PERPENDICULAR TO THE LENGTH OF SIDEWALK.

**CONCRETE SIDEWALK AT
PARKING LOT ENTRANCE DETAIL**
NOT TO SCALE

TREZA SUBDIVISION

VILLAGE OF SOUTH BLOOMING GROVE, ORANGE COUNTY, NEW YORK
PROJECT TITLE

**ROAD PROFILES
& DETAILS**


DRAWING TITLE

KIRK ROTHER, P.E.
CONSULTING ENGINEER, PLLC
5 Saint Stephens Lane, Warwick, NY 10990
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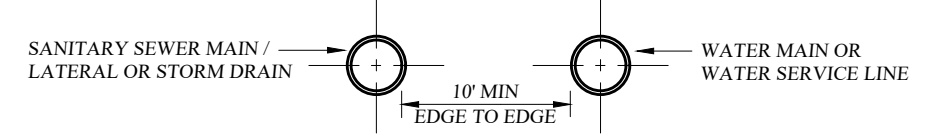
DATE	REVISIONS	KIRK ROTHER, P.E.	N.Y.S. LIC. NO. 079053	DATE
03-06-23	INITIAL PREPARATION			

D.O.T. SHEET #	D.E.C. SHEET #	O.C.H.D. SHEET #	SHEET #
N.A.	N.A.	N.A.	3 OF 4
CAD # 23103	PROJECT #	SCALE	
SKETCH	23103.0	AS SHOWN	

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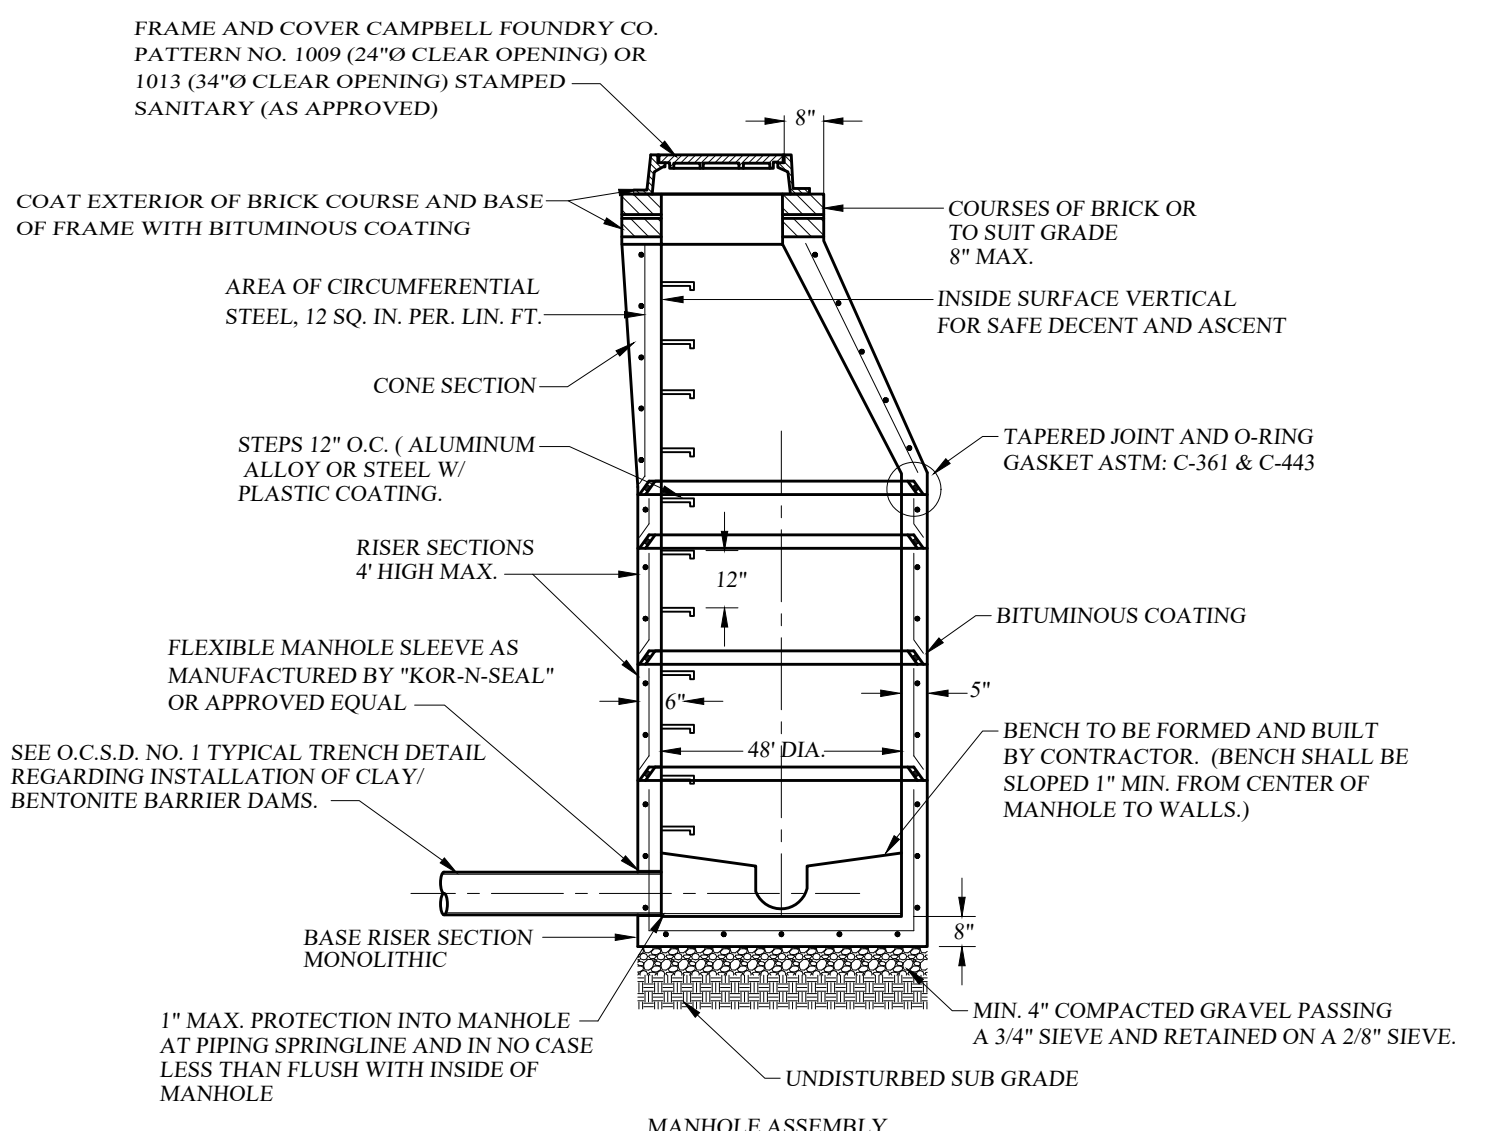
VERTICAL SEPARATION DETAIL
NOT TO SCALE

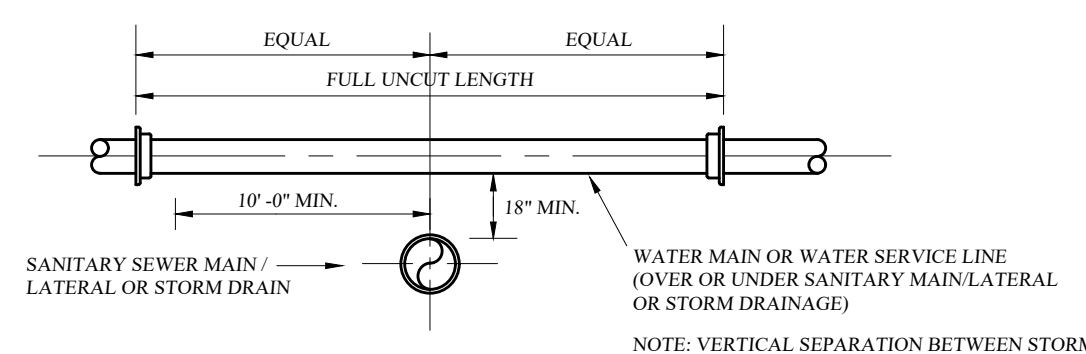

HORIZONTAL SEPARATION DETAIL
NOT TO SCALE


NOTE: THE SEPARATION REQUIREMENT SHALL CONFORM TO CURRENT ORANGE COUNTY DEPARTMENT OF HEALTH STATUTES, CODES, RULES, REGULATIONS AND LAWS AS THEY APPLY. ANY DEVIATION FROM THE ABOVE SEPARATION REQUIREMENTS SHALL REQUIRE WRITTEN APPROVAL FROM THE ORANGE COUNTY DEPARTMENT OF HEALTH.

WATER/SEWER SEPARATION REQUIREMENTS
NOT TO SCALE




PRECAST REINFORCED CONCRETE MANHOLE
NOT TO SCALE

- MANHOLE TO MEET CURRENT REQUIREMENTS OF ASTM C-478
- JOINTS: LOCK TYPE WITH ROUND RUBBER GASKETS. THE WEIGHT OF EACH SECTION MUST MAKE AN INFILTRATION PROOF JOINT BY FORCING THE GASKET TIGHT.
- ALL MATERIALS AND CONSTRUCTION SHALL MEET THE REQUIREMENTS OF O.C.S.D. NO. 1
- MANHOLE TO BE SUITABLE FOR H-20 LOADING.
- MANHOLE EXTERIOR MUST BE 100% BITUMINOUS COATING.

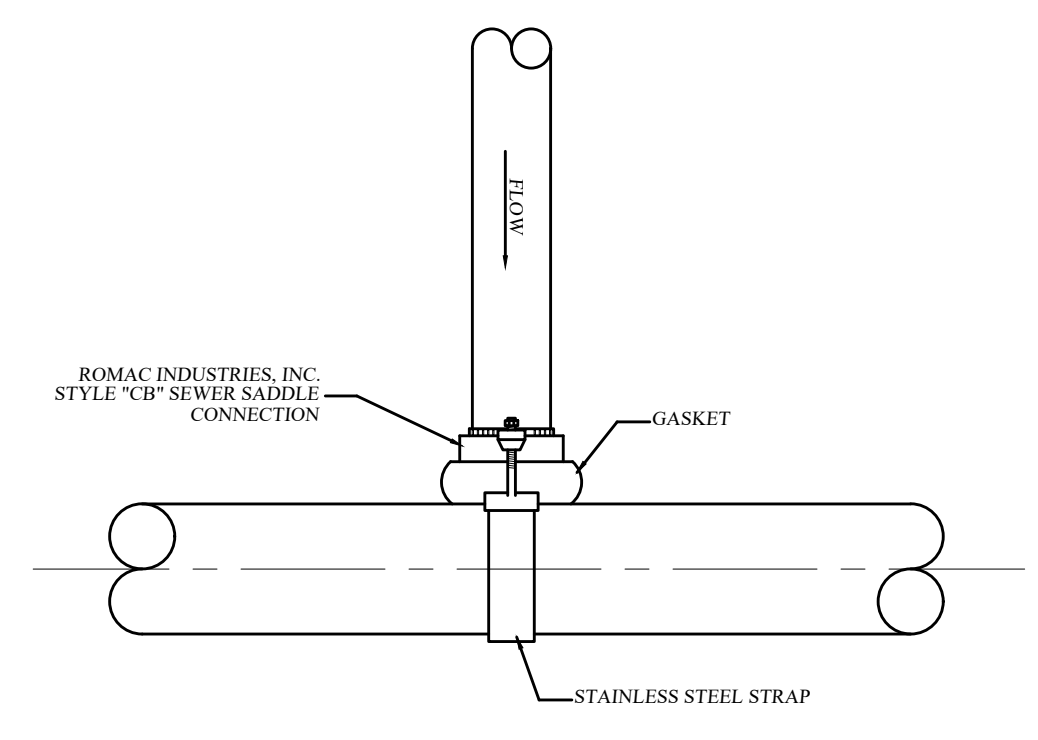


- NOTES:
1. ALL APPROVED BUILDING SEWER PIPE MATERIAL FOR EACH CONNECTION MADE SHALL BE CONSTRUCTED FROM THE SAME MATERIAL.
 2. SADDLE CONNECTION TO BE STYLE "CB" SEWER SADDLE AS MANUFACTURED BY ROMAC INDUSTRIES, INC. OR APPROVED EQUAL.
 3. REFER TO DETAIL SPECIFICATIONS FOR STYLE "CB" SEWER SADDLE AS PROVIDED BY ROMAC INDUSTRIES, INC. FOR INSTALLATION GUIDELINES.
 4. INSTALLATION AND MATERIALS OF THE SADDLE CONNECTION TO CONFORM WITH O.C.S.D. NO. 1 CRITERIA. THERE WILL BE NO DEVIATION FROM THE APPROVED PLAN WITHOUT WRITTEN APPROVAL FROM THE SEWER DEPARTMENT.

SADDLE CONNECTION DETAIL
NOT TO SCALE

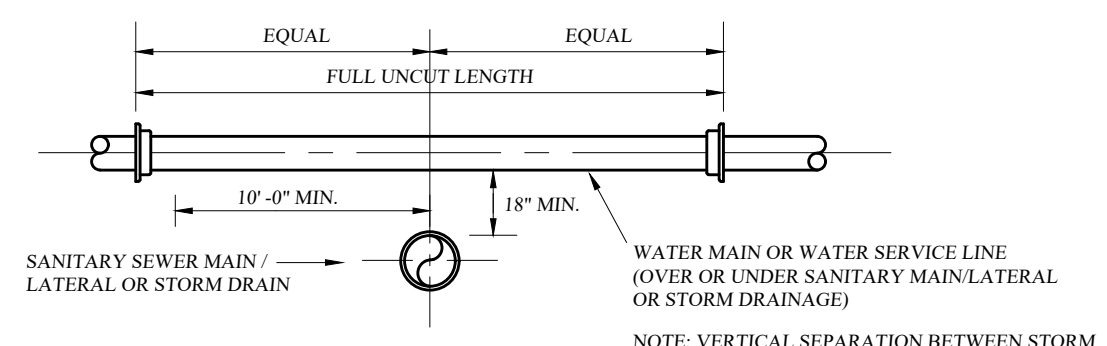



VERTICAL SEPARATION DETAIL
NOT TO SCALE

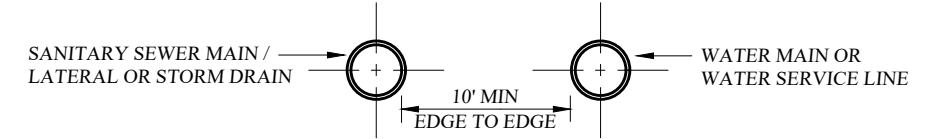

HORIZONTAL SEPARATION DETAIL
NOT TO SCALE




NOTE: THE SEPARATION REQUIREMENT SHALL CONFORM TO CURRENT ORANGE COUNTY DEPARTMENT OF HEALTH STATUTES, CODES, RULES, REGULATIONS AND LAWS AS THEY APPLY. ANY DEVIATION FROM THE ABOVE SEPARATION REQUIREMENTS SHALL REQUIRE WRITTEN APPROVAL FROM THE ORANGE COUNTY DEPARTMENT OF HEALTH.

WATER/SEWER SEPARATION REQUIREMENTS
NOT TO SCALE

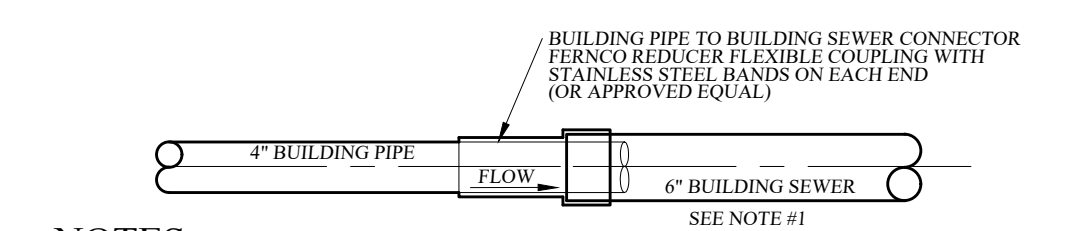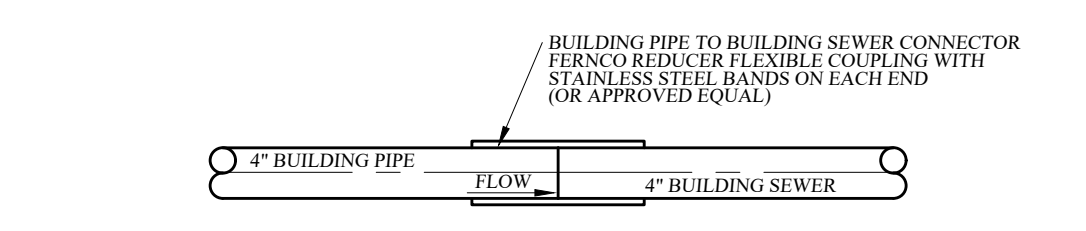

- NOTES:
1. 4" BUILDING PIPE TO STUB APPROXIMATELY 6" INTO 6" BUILDING SEWER.
 2. EACH 4" BUILDING SEWER MAY BE APPROVED FOR CONSTRUCTION OF SINGLE (1) AND TWO (2) FAMILY DWELLINGS ONLY.
 3. EACH 6" BUILDING SEWER SHALL BE REQUIRED FOR ALL COMMERCIAL USES AND SERVE NO MORE THAN TWELVE (12) EQUIVALENT LIVING UNITS, AS DETERMINED BY O.C.S.D. UNLESS A REQUESTED DEVIATION IS APPROVED IN WRITING BY O.C.S.D. NO. 1.
 4. BUILDING PIPE SHALL NOT EXCEED MORE THAN 10' FROM EXTERIOR OF BUILDING FOUNDATION.
 5. 6" BUILDING PIPE TO 6" BUILDING SEWER SHALL BE MADE BY INSTALLING A TYPE 1, STYLE 62 DRESSER COUPLING OR DRESSER STYLE 262 HYRAX COUPLING (OR APPROVED EQUAL).

BUILDING PIPE TO BUILDING SEWER CONNECTION
NOT TO SCALE

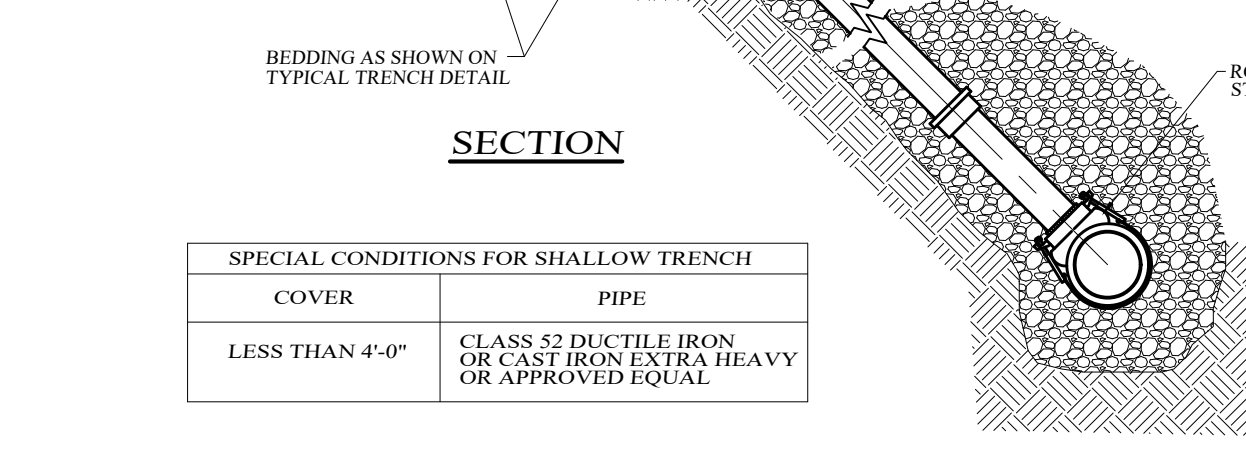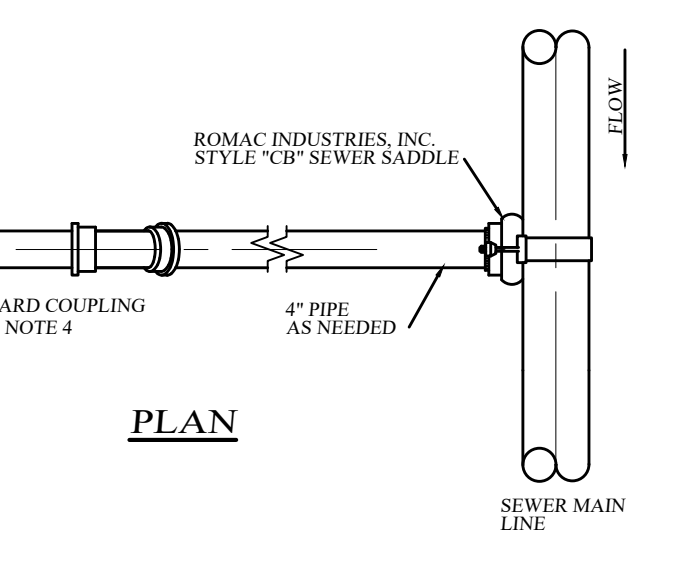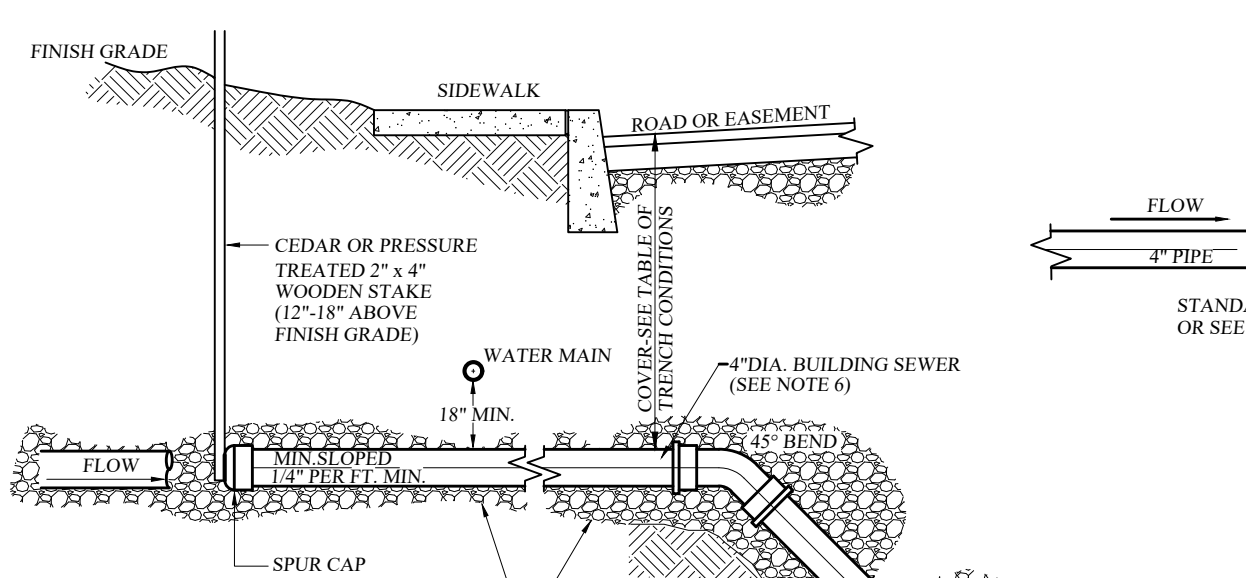


SPECIAL CONDITIONS FOR SHALLOW TRENCH

COVER	PIPE
LESS THAN 4'-0"	CLASS 52 DUCTILE IRON OR CAST IRON EXTRA HEAVY OR APPROVED EQUAL


- NOTES:
1. EACH 6" BUILDING SEWER SHALL PROVIDE SERVICE FOR NO MORE THAN TWELVE (12) EQUIVALENT LIVING UNITS, AS DETERMINED BY O.C.S.D. NO. 1 UNLESS A REQUESTED DEVIATION IS APPROVED IN WRITING BY SEWER DEPARTMENT.
 2. ALL APPROVED BUILDING SEWER PIPE MATERIAL FOR EACH CONNECTION MADE SHALL BE CONSTRUCTED FROM THE SAME MATERIAL.
 3. MINIMUM HORIZONTAL SEPARATION BETWEEN SPUR CAP AND SIDEWALK SHALL BE 2'-0". IN ALL CASES THE SPUR CAP LOCATION SHALL EXTEND A MINIMUM HORIZONTAL DISTANCE OF 2'-0" TO ALL BUILDING LOT PROPERTIES.
 4. TRANSITION BETWEEN DIFFERENT PIPE MATERIAL (AS APPROVED) SHALL BE MADE BY INSTALLING A TYPE 1, STYLE 62 DRESSER COUPLING OR DRESSER STYLE 262 HYRAX COUPLING (OR APPROVED EQUAL).
 5. SADDLE CONNECTION SHALL BE A FITTING CONSTRUCTED SPECIFICALLY FOR THE INSTALLED MAIN LINE SEWER MATERIAL CLASS (OR APPROVED EQUAL).
 6. THE BUILDING SEWER SHOWN FROM THE MAIN LINE SOURCE SADDLE CONNECTION FITTING TO THE SPUR CAP SHALL MEET THE SPECIFICATIONS SHOWN FOR 6" BUILDING SEWER SERVICE LATERALS.
 7. 4" BUILDING SEWER LATERAL MAY BE APPROVED FOR CONSTRUCTION OF SINGLE (1) AND TWO (2) FAMILY DWELLINGS ONLY. ALL OTHER BUILDING LATERAL SEWERS (INCLUDING COMMERCIAL) SHALL BE 6" IN DIA. -

SEWER MAIN CONNECTION DETAIL
NOT TO SCALE

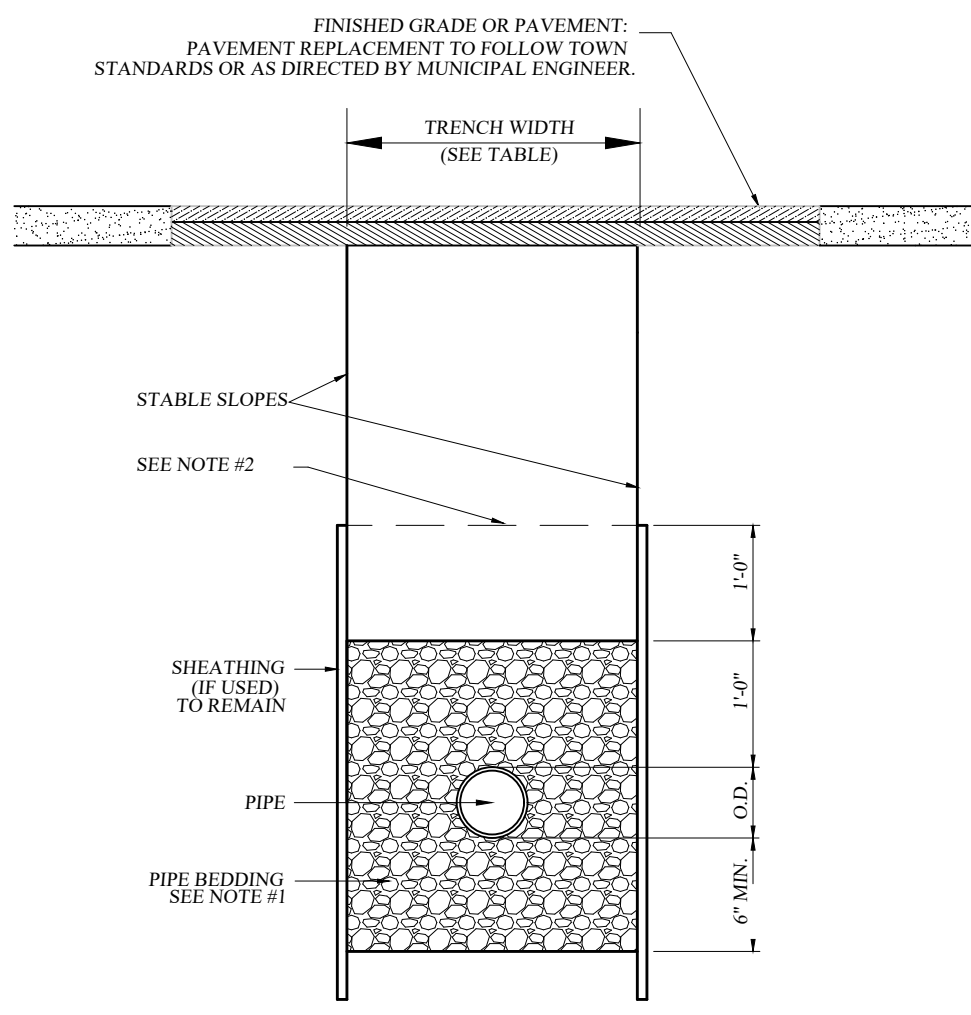

PIPE O.D.	TRENCH WIDTH
24" AND SMALLER	O.D. + 1'-4"
30" AND LARGER	O.D. + 2'-0"


TYPICAL TRENCH DETAIL (SANITARY SEWER)
NOT TO SCALE

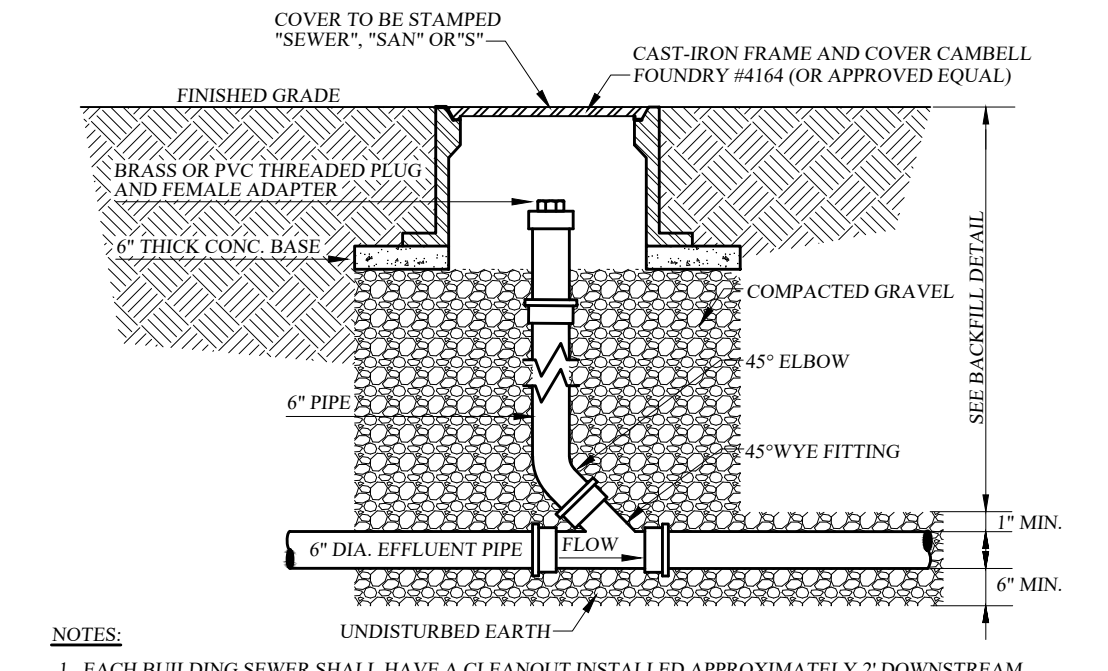

- NOTES:
1. BUILDING SEWER SHALL HAVE A CLEANOUT INSTALLED APPROXIMATELY 2' DOWNSTREAM OF THE BUILDING PIPE TO BUILDING SEWER CONNECTION. THEREAFTER, CLEANOUTS SHALL BE INSTALLED ALONG THE BUILDING SEWER APPROXIMATELY EVERY 100' MAXIMUM FOR THE PURPOSE OF CLEANOUT LOCATIONS. DISTANCE SHALL BE MEASURED FROM THE FIRST CLEANOUT LOCATED DOWNSTREAM OF THE HOUSE PIPE TO BUILDING SEWER CONNECTION, HENCE DOWNSTREAM ALONG THE BUILDING SEWER TO THE CENTER OF THE SEWER MAIN LINE (GENERALLY LOCATED IN THE CENTER OF THE STREET).
 2. A CLEANOUT LOCATED IN A ROAD, DRIVEWAY OR PARKING AREA SHALL REQUIRE A CAMPBELL FOUNDRY #4164 CAST IRON FRAME AND COVER. (OR APPROVED EQUAL)

BUILDING SEWER CLEAN-OUT DETAIL
NOT TO SCALE

- Notes:
- 1) PIPE BEDDING SHALL BE A CLASS A (ASTM D2321) EMBEDMENT MATERIAL THAT SHALL BE EITHER CRUSHED STONE OR WASHED GRAVEL PASSING A 3/4" SIEVE AND RETAINED ON 3/8" SIEVE. THE EMBEDMENT MATERIAL SHALL BE HAND TAMPED AND COMPACTED TO 90% OF THE MAXIMUM DENSITY OF THE EMBEDMENT MATERIAL AS DETERMINED BY STANDARD PROCTOR TEST IN ACCORDANCE WITH ASHTO DESIGNATION T-99. THE CONTRACTOR SHALL BE RESPONSIBLE TO PROVIDE A GO-NO-GO TESTING GAUGE, AS DEFINED IN THE GREEN-TITE (TRADEMARK) PVC GRAVITY SEWER PIPE INSTALLATION GUIDE AS PUBLISHED BY J-M PIPE (OR APPROVED EQUAL) FOR TESTING DEFLECTION OF MAIN LINE SEWER PIPE, AS DIRECTED BY O.C.S.D. MAXIMUM MAIN LINE SEWER DEFLECTION SHALL BE NO GREATER THAN 5%.
 - 2) BACKFILL FROM 12 IN. TO 24 IN. ABOVE THE PIPE EMBEDMENT MATERIAL SHALL BE FINE EARTH FREE FROM CINDERS AND SHALL BE MECHANICALLY COMPACTED. REMAINING BACKFILL SHALL BE FREE FROM LARGE CLODS, NATURAL DEBRIS, ROCKS, AND CINDERS.
 - 3) PLACE EMBEDMENT MATERIAL BY HAND AND HAND COMPACT UNDER AND AROUND SIDES OF PIPE. PLACE EMBEDMENT MATERIAL IN 6" LAYERS ABOVE TOP OF PIPE, AND HAND COMPACT TO A POINT 12 INCH MAXIMUM ABOVE THE TOP OF PIPE.
 - 4) THE OWNER AND CONTRACTOR SHALL BE RESPONSIBLE TO PROVIDE A COMPETENT PERSON DURING ALL PHASES OF CONSTRUCTION WHOSE DUTY SHALL BE TO INSURE THAT ALL PHASES OF CONSTRUCTION ARE IN FULL COMPLIANCE WITH O.C.S.D. NO. 1 SPECIFICATIONS AND ALL APPLICABLE FEDERAL, STATE AND LOCAL STATUTES, CODES, RULES, REGULATIONS AND LAWS INCLUDING, BUT NOT LIMITED TO, UNITED STATES DEPARTMENT OF LABOR FOR OCCUPATIONAL SAFETY AND HEALTH ADMINISTRATION AND N.Y.S. DEPARTMENT OF LABOR FOR SECTION 1910.146 PERMIT REQUIRED CONFINED SPACE ENTRY, OCCUPATIONAL SAFETY AND HEALTH ADMINISTRATION REQUIREMENTS AND OSHA SECTION 1926.651 TRENCHING AND SHORING, STATE OF NEW YORK UNIFORM FIRE PREVENTION AND BUILDING CODES AND NATIONAL FIRE PROTECTION ASSOCIATION CODES.
 - 5) ALL APPROVED MAIN LINE SEWER PIPE SHALL BE THE SAME MATERIAL FROM MAN-HOLE TO MAN-HOLE.
 - 6) FILL SECTION AREA MUST BE GRADED WITH THE PLACEMENT OF SUITABLE SOIL MATERIAL, AS DETERMINED BY THE PROJECT SITE ENGINEER, IN 12" (MAX) LAYERS COMPACTED TO 95% OF THE MAXIMUM DENSITY OF THE SOIL AS DETERMINED BY THE STANDARD PROCTOR TEST (ASHTO DESIGNATION T-99) TO 2'-0" (MIN.) ABOVE TOP OF PIPE AT A MINIMUM WIDTH OF O.D. + 4'-0" BEFORE TRENCH EXCAVATING.
 - 7) WHERE ROCK IS ENCOUNTERED IN TRENCH BOTTOM, UNDERCUT MUST BE MADE BETWEEN 12" MIN. TO 24" MAX.
 - 8) WHERE UNSUITABLE MATERIAL IS ENCOUNTERED IN TRENCH BOTTOM, UNDERCUT TO SUITABLE MATERIAL (AS APPROVED BY TOWN ENGINEER).

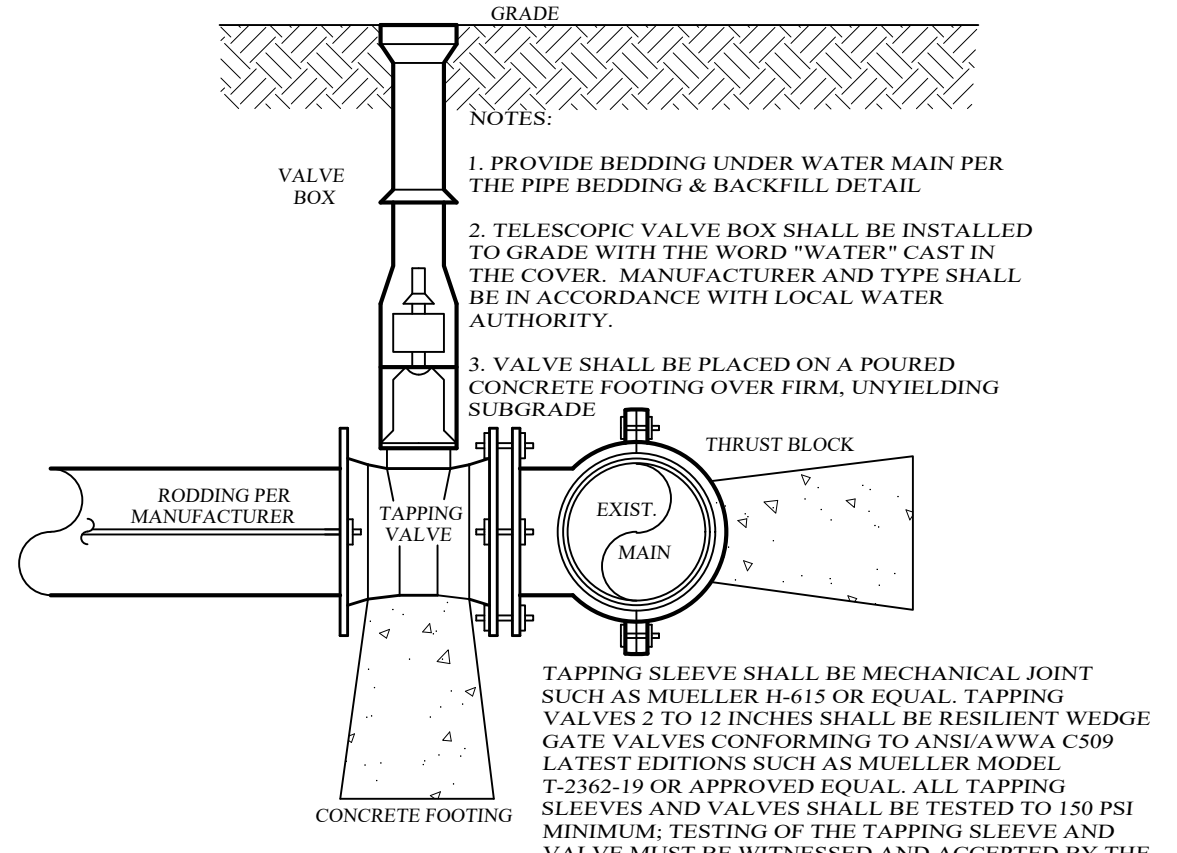

WATER MAIN TAPPING VALVE DETAIL
NOT TO SCALE

- NOTES:
1. PROVIDE BEDDING UNDER WATER MAIN PER THE PIPE BEDDING & BACKFILL DETAIL.
 2. TELESCOPIC VALVE BOX SHALL BE INSTALLED TO GRADE WITH THE WORD "WATER" CAST IN THE COVER. MANUFACTURER AND TYPE SHALL BE IN ACCORDANCE WITH LOCAL WATER AUTHORITY.
 3. VALVE SHALL BE PLACED ON A POURED CONCRETE FOOTING OVER FIRM, UNYIELDING SUBGRADE.

TREZA SUBDIVISION

VILLAGE OF SOUTH BLOOMING GROVE, ORANGE COUNTY, NEW YORK
PROJECT TITLE

SANITARY DETAILS

DRAWING TITLE

KIRK ROTHER, P.E. CONSULTING ENGINEER, PLLC

5 Saint Stephens Lane, Warwick, NY 10990
(845) 988-0620

DATE	REVISIONS	KIRK ROTHER, P.E.	N.Y.S. LIC. NO. 079053	DATE
03-06-23	INITIAL PREPARATION			

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	N.A.	N.A.	N.A.	4 OF 4
	CAD # 23103	PROJECT #	SCALE	
	SKETCH	23103.0	AS SHOWN	